



US Army Corps
of Engineers
Alaska District

Public Notice of Application for Permit

Regulatory Branch (1145b)
Post Office Box 6898
Elmendorf AFB, Alaska 99506-6898

PUBLIC NOTICE DATE: 18 October 2004
EXPIRATION DATE: 17 November 2004
REFERENCE NUMBER: POA-2004-1149-4
WATERWAY NAME: Postmark Bog

Interested parties are hereby notified that an application has been received for a Department of the Army permit for certain work in waters of the United States as described below and shown on the attached plan.

APPLICANT: Ted Stevens Anchorage International Airport (ANC), State of Alaska, P.O. Box 196960, Anchorage, Alaska 99519-6960.

LOCATION: The project is located west of Postmark Drive, southeast of the intersection of Taxiway U and Taxiway R. The project is located in the SE quarter of section 28, Township 13 N., Range 4 W., Seward Meridian, Latitude 61°11'13" N., Longitude 149°59'56" W.

WORK: The project would require excavation of approximately 46,500 cubic yards of organic material and placement of approximately 176,300 cubic yards of clean fill and construction of a refueling apron, three refueling hardstands, a tug road, and a taxi lane. Approximately 8.5 acres of wetlands would be filled. The footprint of the fill for the Remote Refueling Apron and associated facilities would be approximately 1,062 feet by 750 feet.

PURPOSE: Replace three remote refueling stands that were removed when the airport developed Concourse C.

ADDITIONAL INFORMATION: Cargo-related development in this area has been in the Airport's Master Plans since 1989. Uncontaminated excavated material would be disposed of in a site approved by the Municipality of Anchorage and ANC that is southwest of the west end of runway 6R. If contaminated soil is encountered, it would be disposed of in a location appropriate to its level of contamination. Clean fill material would be imported from an approved facility. ANC intends to implement appropriate Best Management Practices for storm water to prevent construction erosion from reaching the storm drainage system.

MITIGATION: As a result of previous actions, ANC has mitigation credits available for its use. ANC proposes to use an appropriate amount of these credits to offset the debits generated by the proposed project.

WATER QUALITY CERTIFICATION: A permit for the described work will not be issued until a certification or waiver of certification as required under Section 401 of

the Clean Water Act (Public Law 95-217), has been received from the Alaska Department of Environmental Conservation.

COASTAL ZONE MANAGEMENT ACT CERTIFICATION: Section 307(c)(3) of the Coastal Zone, Management Act of 1972, as amended by 16 U.S.C. 1456(c)(3), requires the applicant to certify that the described activity affecting land or water uses in the Coastal Zone complies with the Alaska Coastal Management Program. A permit will not be issued until the Office of Project Management and Permitting, Department of Natural Resources has concurred with the applicant's certification.

PUBLIC HEARING: Any person may request, in writing, within the comment period specified in this notice, that a public hearing be held to consider this application. Requests for public hearings shall state, with particularity, reasons for holding a public hearing.

CULTURAL RESOURCES: The latest published version of the Alaska Heritage Resources Survey (AHRS) has been consulted for the presence or absence of historic properties, including those listed in or eligible for inclusion in the National Register of Historic Places. There are no listed or eligible properties in the vicinity of the worksite. Consultation of the AHRS constitutes the extent of cultural resource investigations by the District Engineer at this time, and he is otherwise unaware of the presence of such resources. This application is being coordinated with the State Historic Preservation Office (SHPO). Any comments SHPO may have concerning presently unknown archeological or historic data that may be lost or destroyed by work under the requested permit will be considered in our final assessment of the described work.

ENDANGERED SPECIES:

No threatened or endangered species are known to use the project area.

ESSENTIAL FISH HABITAT: The proposed work is being evaluated for possible effects to Essential Fish Habitat (EFH) pursuant to the Magnuson Stevens Fishery Conservation and Management Act of 1996 (MSFCMA), 16 U.S.C. et seq and associated federal regulations found at 50 CFR 600 Subpart K. The Alaska District includes areas of EFH as Fishery Management Plans. We have reviewed the January 20, 1999, North Pacific Fishery Management Council's Environmental Assessment to locate EFH area as identified by the National Marine Fisheries Service (NMFS).

We have determined that the described activity within the proposed area will not adversely affect EFH, including anadromous fish and federally managed fishery resources.

SPECIAL AREA DESIGNATION: None.

EVALUATION: The decision whether to issue a permit will be based on an evaluation of the probable impacts including cumulative impacts of the proposed activity and its intended use on the public interest. Evaluation of the probable impacts, which the proposed activity may have on the public interest, requires a careful weighing of all the factors that become relevant in each particular case. The benefits, which reasonably may be expected to accrue from the proposal, must be balanced against its reasonably foreseeable detriments. The decision whether to authorize a proposal, and if so, the conditions under which it will be allowed to occur, are therefore determined by the outcome of the general balancing process. That decision should reflect the national concern for both protection and utilization of important resources. All factors, which may be relevant to the proposal, must be considered including the cumulative effects thereof. Among those are conservation, economics, aesthetics, general environmental concerns, wetlands, cultural values, fish and wildlife values, flood hazards, floodplain values, land use, navigation, shore erosion and accretion, recreation, water supply and conservation, water quality, energy needs, safety, food and fiber

production, mineral needs, considerations of property ownership, and, in general, the needs and welfare of the people. For activities involving 404 discharges, a permit will be denied if the discharge that would be authorized by such permit would not comply with the Environmental Protection Agency's 404(b)(1) guidelines. Subject to the preceding sentence and any other applicable guidelines or criteria (see Sections 320.2 and 320.3), a permit will be granted unless the District Engineer determines that it would be contrary to the public interest.

The Corps of Engineers is soliciting comments from the public; Federal, State, and local agencies and officials; Indian Tribes; and other interested parties in order to consider and evaluate the impacts of this proposed activity. Any comments received will be considered by the Corps of Engineers to determine whether to issue, modify, condition or deny a permit for this proposal. To make this decision, comments are used to assess impacts on endangered species, historic properties, water quality, general environmental effects, and the other public interest factors listed above. Comments are used in the preparation of an Environmental Assessment and/or an Environmental Impact Statement pursuant to the National Environmental Policy Act. Comments are also used to determine the need for a public hearing and to determine the overall public interest of the proposed activity.

Comments on the described work, with the reference number, should reach this office no later than the expiration date of this Public Notice to become part of the record and be considered in the decision. Please contact Ms. Maureen McCrea at (907) 753-2724, toll free from within Alaska at (800) 478-2712, or by email at Maureen.McCrea@poa02.usace.army.mil if further information is desired concerning this notice.

AUTHORITY: This permit will be issued or denied under the following authorities:

(X) Discharge dredged or fill material into waters of the United States - Section 404 Clean Water Act (33 U.S.C. 1344). Therefore, our public interest review will consider the guidelines set forth under Section 404(b) of the Clean Water Act (40 CFR 230).


A plan, Notice of Application for Certification of Consistency with the Alaska Coastal Management Program, and Notice of Application for State Water Quality Certification are attached to this Public Notice.

District Engineer
U.S. Army, Corps of Engineers


Attachment(s)



LOCATION MAP
SCALE: NOT TO SCALE

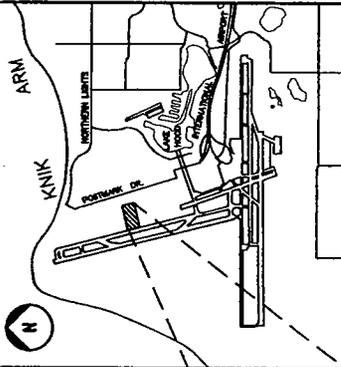


VICINITY MAP
SCALE: NOT TO SCALE

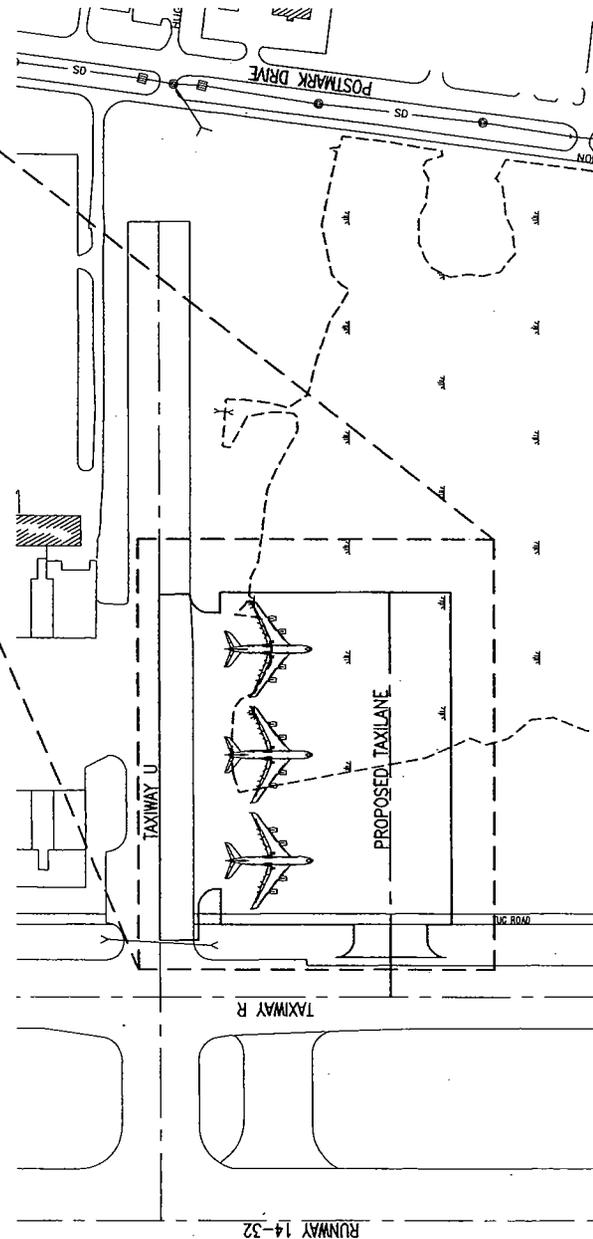

PROJECT LOCATION MAP

GRAPHIC SCALE

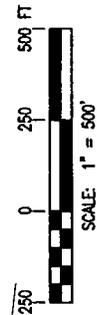


DATE: 9/18/04
 DESIGN: JSC
 DRAWN: JRCA
 CHECKED: JRCA

TED STEVENS ANCHORAGE INTERNATIONAL AIRPORT
 REMOTE REFUELING APRON
 POSTMARK CARGO SITE
 PROJECT NO. 53860

LOCATION, VICINITY, PROJECT LOCATION MAPS

POA-2004-1149-4
 Postmark Bog
 Ted Stevens Anchorage
 International Airport
 Remote Refueling Apron
 September 2004 Sheet 1 of 5

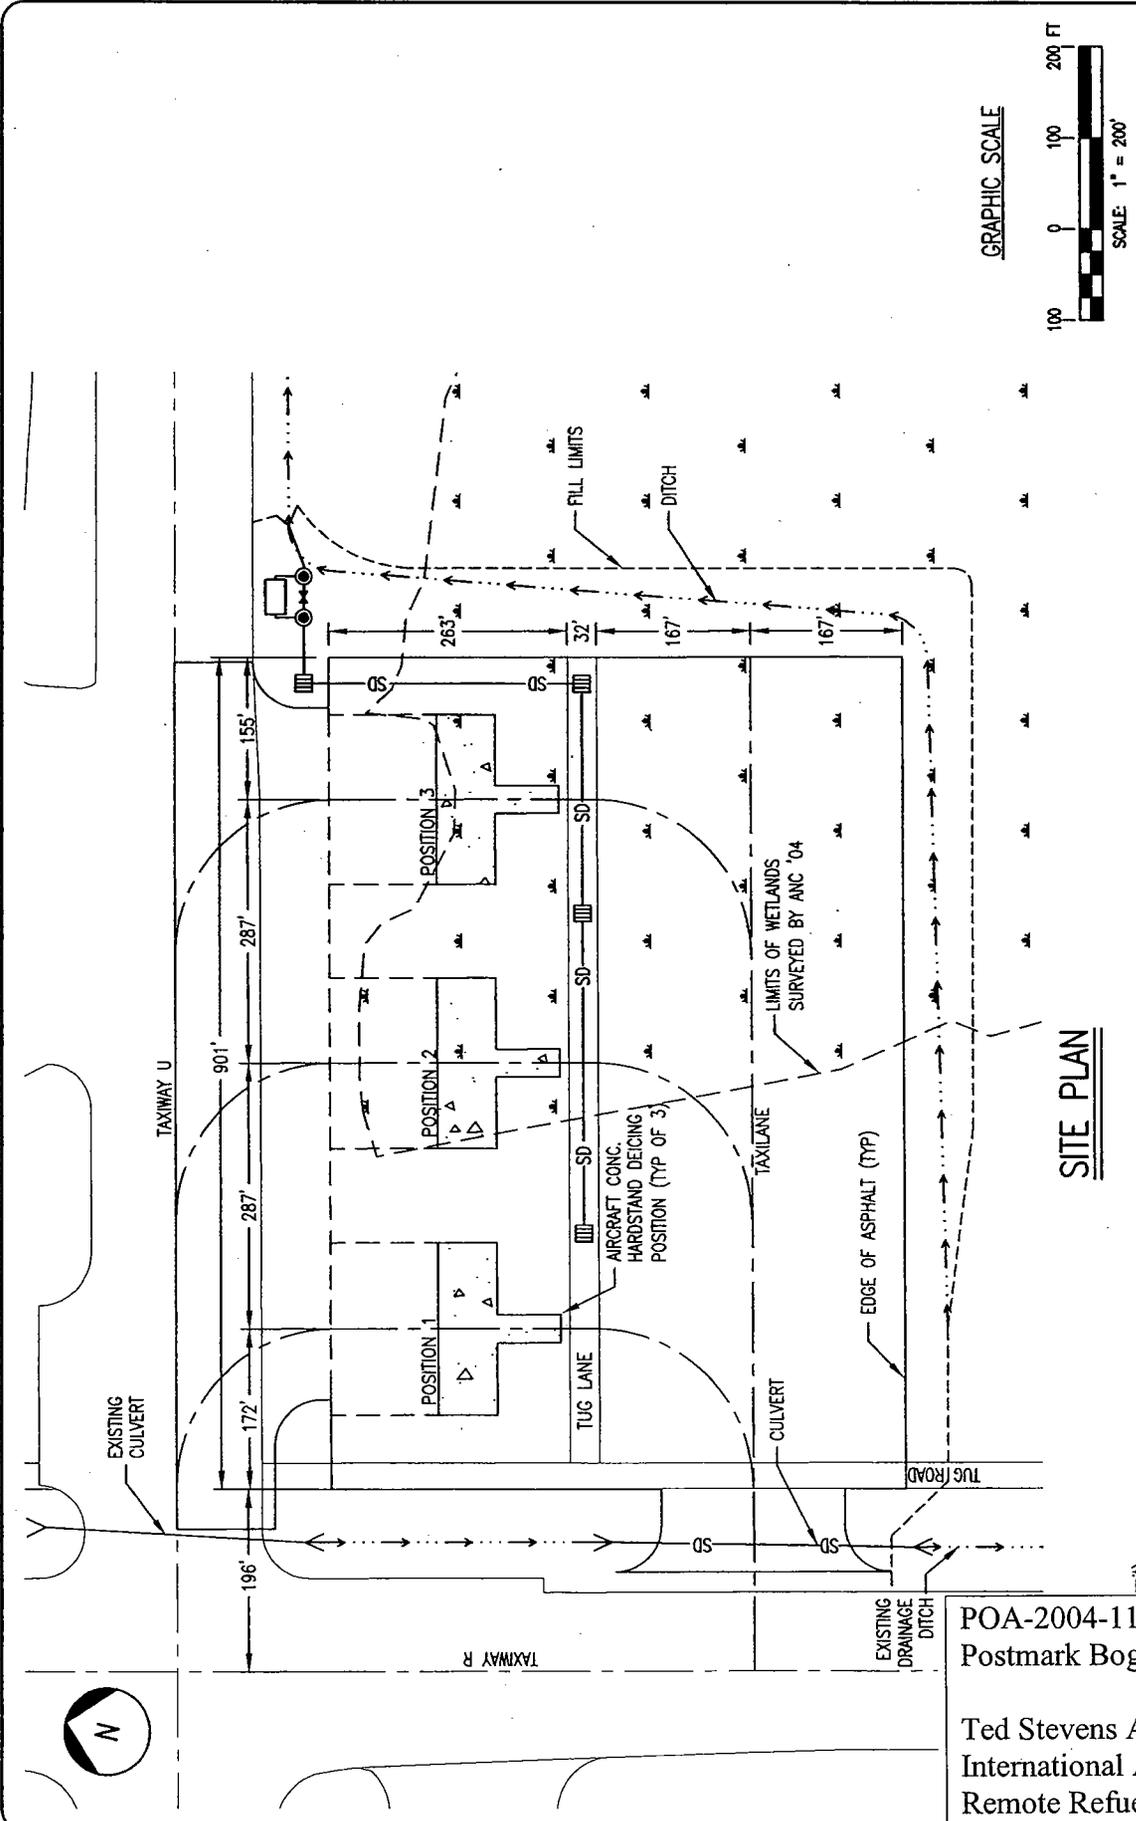

GRAPHIC SCALE
 100 0 100 200 FT
 SCALE: 1" = 200'

DATE: 9/19/04
 DESIGN: JSC
 DRAWN: JRC
 CHECKED: JRC


TED STEVENS ANCHORAGE
 INTERNATIONAL AIRPORT
 REMOTE REFUELING APRON
 POSTMARK CARGO SITE
 PROJECT NO. 63860

SITE PLAN

SITE PLAN

POA-2004-1149-4
 Postmark Bog

Ted Stevens Anchorage
 International Airport
 Remote Refueling Apron

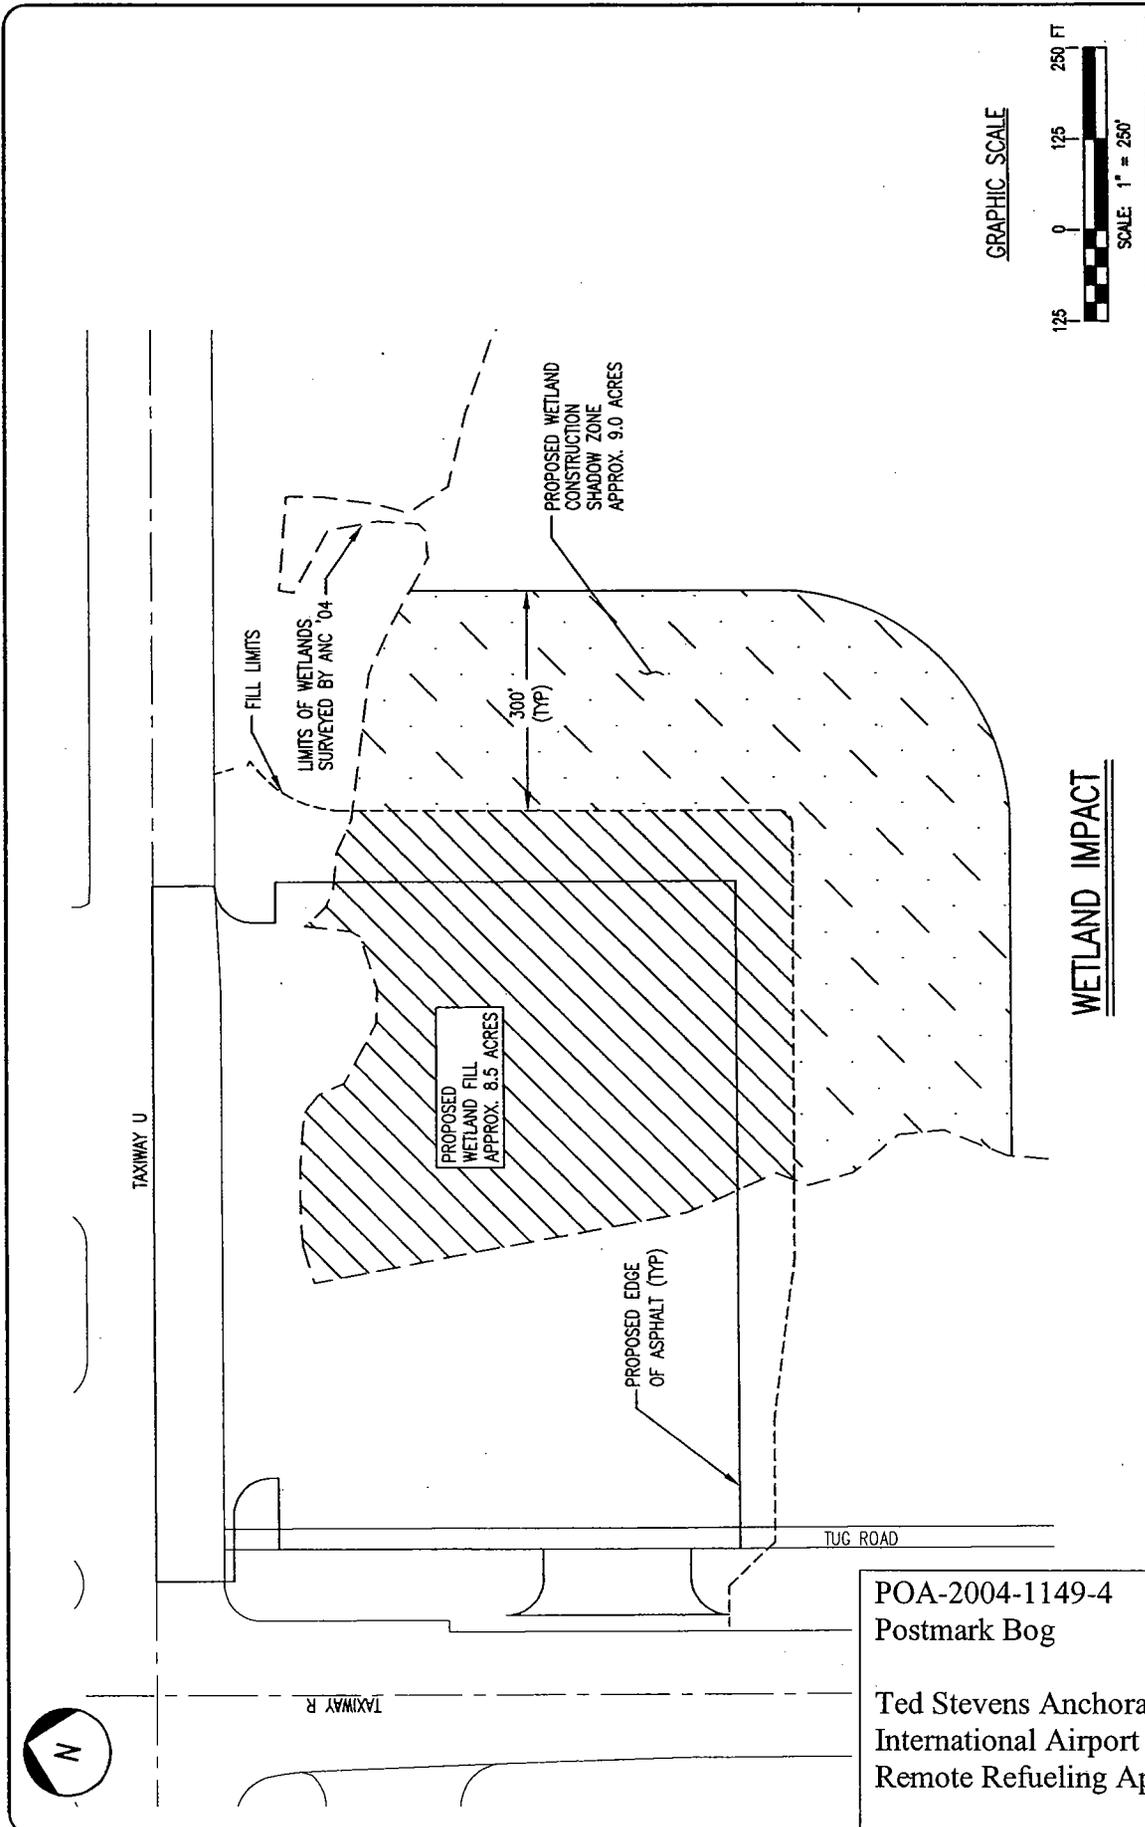

GRAPHIC SCALE





WETLAND IMPACT

DATE: 9/16/04
 DESIGN: JSC
 DRAWN: JBCA
 CHECKED: JBCA


TED STEVENS ANCHORAGE INTERNATIONAL AIRPORT
 REMOTE REFUELING APRON
 POSTMARK CARGO SITE
 PROJECT NO. 63680

WETLAND IMPACT PLAN

POA-2004-1149-4
 Postmark Bog
 Ted Stevens Anchorage International Airport
 Remote Refueling Apron
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GRAPHIC SCALES

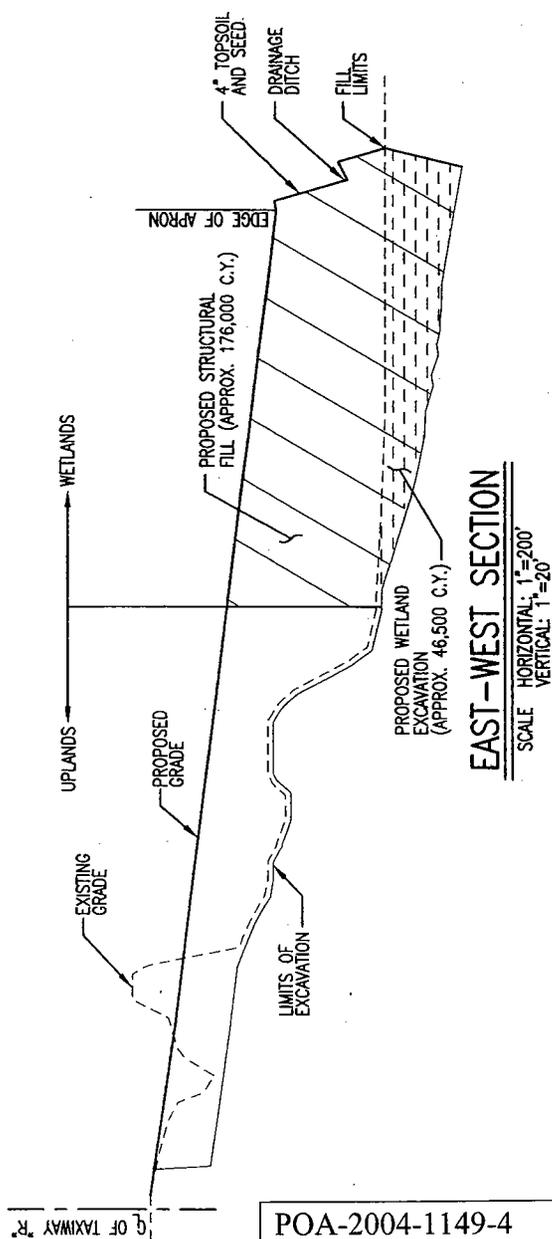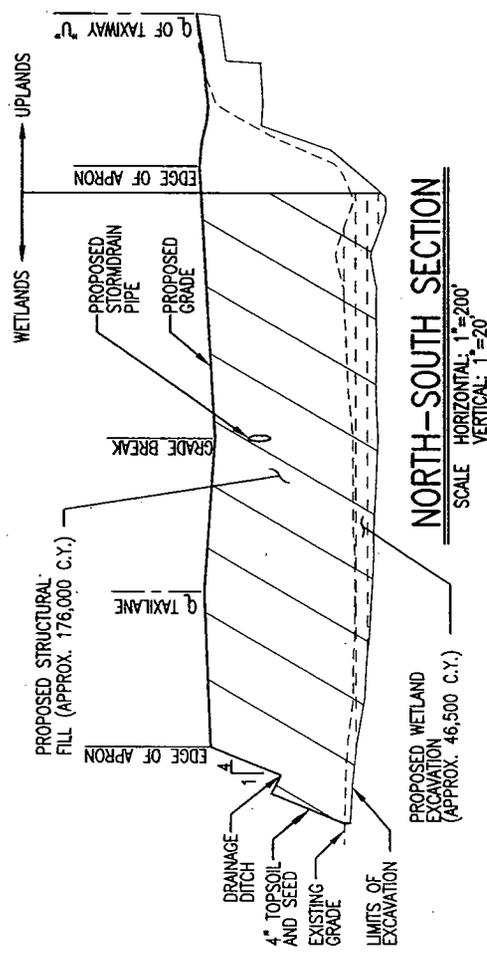


DATE: 9/19/04
 DESIGN: JSC
 DRAWN: JBC
 CHECKED: JBC

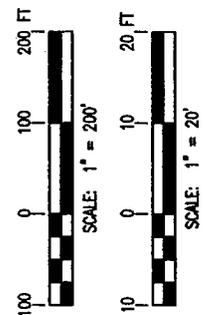TED STEVENS ANCHORAGE INTERNATIONAL AIRPORT
 REMOTE REFUELING APRON
 POSTMARK CARGO SITE
 PROJECT NO. 63860

SITE SECTIONS

POA-2004-1149-4
 Postmark Bog

Ted Stevens Anchorage
 International Airport
 Remote Refueling Apron

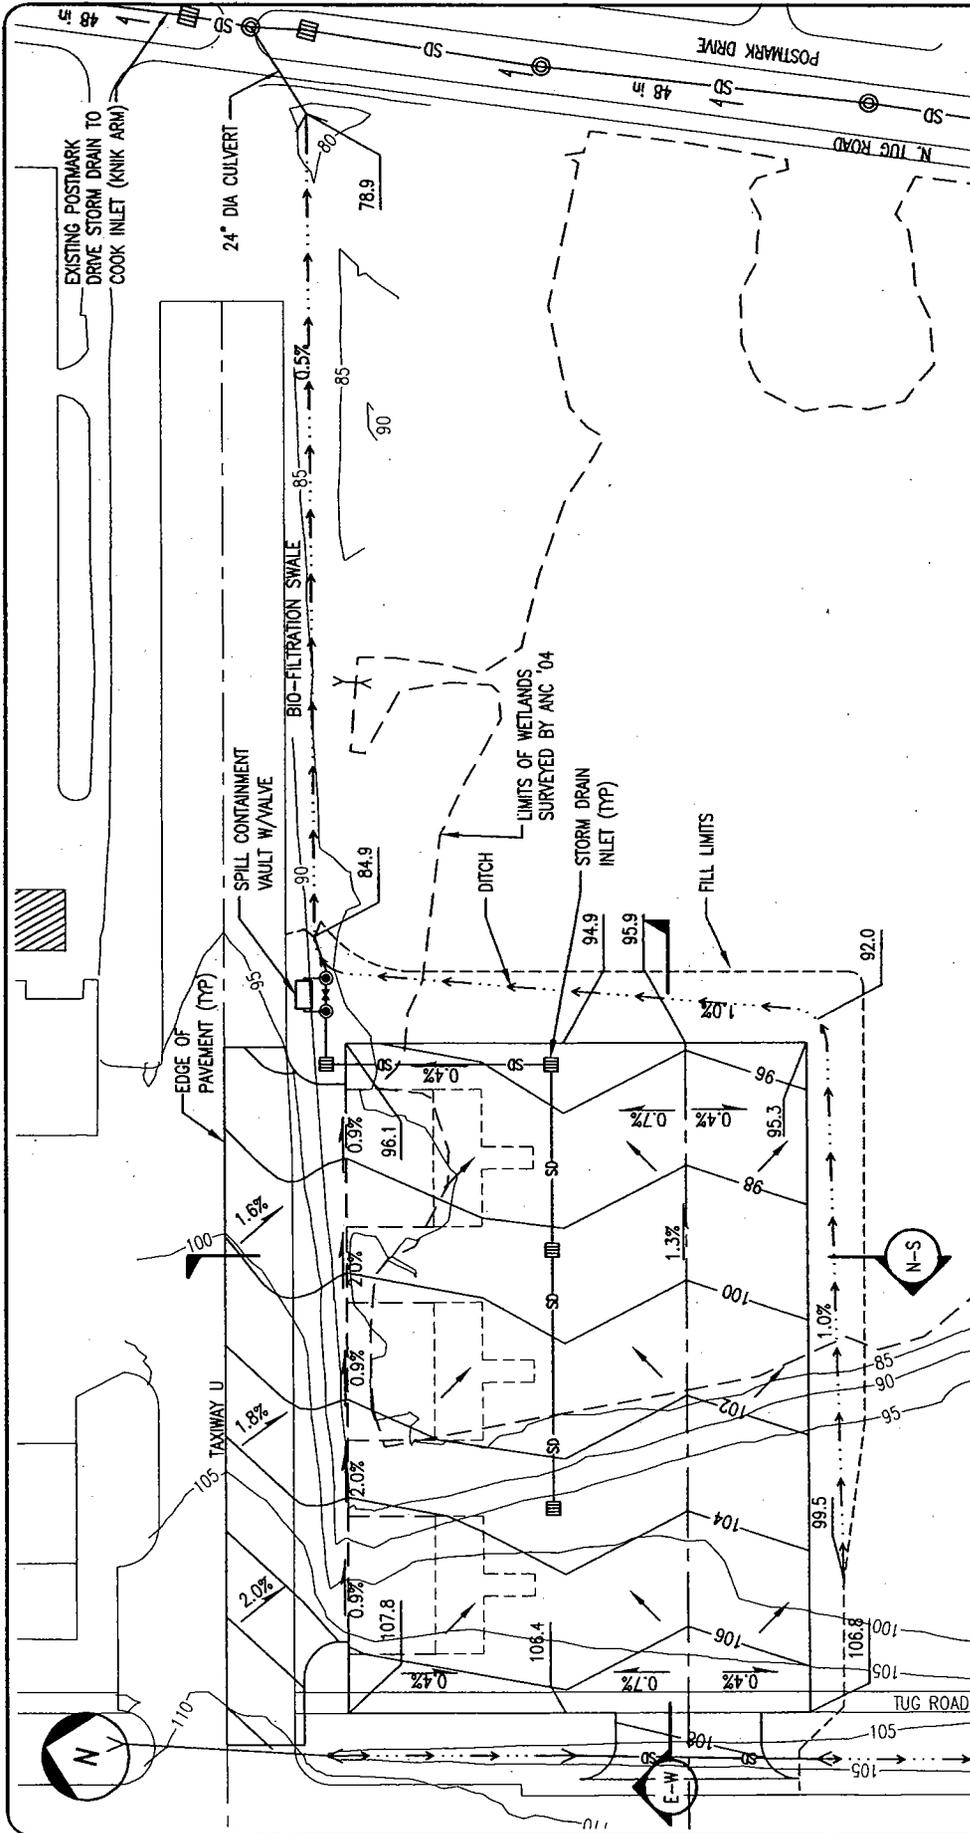

GRAPHIC SCALE



GRADING AND DRAINAGE PLAN

DATE: 9/18/04
 DESIGNER: JSC
 CHECKER: JSC
 CHECKED: JSC

TED STEVENS ANCHORAGE
 INTERNATIONAL AIRPORT
 REMOTE REFUELING APRON
 POSTMARK CARGO SITE
 PROJECT NO. 53680

GRADING AND DRAINAGE PLAN

POA-2004-1149-4
 Postmark Bog
 Ted Stevens Anchorage
 International Airport
 Remote Refueling Apron
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STATE OF ALASKA

OFFICE OF THE GOVERNOR

DEPT. OF ENVIRONMENTAL CONSERVATION

DIVISION OF WATER

401 Certification Program

Non-Point Source Water Pollution Control Program

NOTICE OF APPLICATION FOR STATE WATER QUALITY CERTIFICATION

Any applicant for a federal license or permit to conduct an activity that might result in a discharge into navigable waters, in accordance with Section 401 of the Clean Water Act of 1977 (PL95-217), also must apply for and obtain certification from the Alaska Department of Environmental Conservation that the discharge will comply with the Clean Water Act, the Alaska Water Quality Standards, and other applicable State laws. By agreement between the U.S. Army Corps of Engineers and the Department of Environmental Conservation, application for a Department of the Army permit to discharge dredged or fill material into navigable waters under Section 404 of the Clean Water Act also may serve as application for State Water Quality Certification.

Notice is hereby given that the application for a Department of the Army Permit described in the Corps of Engineers' Public Notice No. **POA-2004-1149-4, Postmark Bog**, serves as application for State Water Quality Certification from the Department of Environmental Conservation.

After reviewing the application, the Department may certify that there is reasonable assurance that the activity, and any discharge that might result, will comply with the Clean Water Act, the Alaska Water Quality Standards, and other applicable State laws. The Department also may deny or waive certification.

Any person desiring to comment on the project with respect to Water Quality Certification may submit written comments within 30 days of the date of the Corps of Engineer's Public Notice to:

Department of Environmental Conservation
WQM/401 Certification
555 Cordova Street
Anchorage, Alaska 99501-2617
Telephone: (907) 269-6281
FAX: (907) 269-7508

FRANK H. MURKOWSKI,
GOVERNOR

STATE OF ALASKA

OFFICE OF THE GOVERNOR

**DEPARTMENT OF NATURAL RESOURCES
OFFICE OF PROJECT MANAGEMENT AND PERMITTING**

ALASKA COASTAL ZONE MANAGEMENT
550 WEST 7TH AVENUE, SUITE 1660
ANCHORAGE, ALASKA 99501-3568

**NOTICE OF APPLICATION
FOR
CERTIFICATION OF CONSISTENCY WITH THE
ALASKA COASTAL MANAGEMENT PROGRAM**

Notice is hereby given that a request is being filed with the Office of Project Management and Permitting for a consistency determination, as provided in Section 307(c)(3) of the Coastal Zone Management Act of 1972, as amended [16 U.S.C. 1456(c)(3)], that the project described in the Corps of Engineers Public Notice No. **POA-2004-1149-4, Postmark Bog**, will comply with the Alaska Coastal Management Program and that the project will be conducted in a manner consistent with that program.

The Office of Project Management and Permitting requests your comments, particularly on the proposed project's consistency with the affected local coastal district management program. For more information on the consistency review contact OPMP at (907) 269-7470 or (907) 465-3562, or visit the ACMP web site at <http://www.gov.state.ak.us/gdc/Projects/projects.html>.

Attachment 3